ATTACHMENT 10—ZONING DRAWINGS

LAND USE APPLICATION—CUP

Wireless Telecommunications Facility AT&T (SP4359 Othello Downtown NSB)

PROJECT DESCRIPTION

AT&T PROPOSES THE INSTALLATION OF A 100'-0" TRI-POLE BELL TOWER C/W (6) PANEL ANTENNAS, (6) RRH UNITS AND AN EQUIPMENT/GENERATOR SHELTER IN A 30'x30' COMPOUND.

PROJECT INFORMATION

SITE ADDRESS

640 E ELM ST

OTHELLO, WA 99344

LATITUDE: 46.820344 N

LONGITUDE -119 166256 W

JURISDICTION:

CITY OF OTHELLO

ZONED:

PROPOSED USE: UNMANNED TELECOMMUNICATIONS FACILITY

OCCUPANCY:

A.P.N. 1529030680155

R-2

ZONING DESIGNATION: PUBLIC USE

RF DATA SHEET

DATE ISSUED: N/A VERSION: N/A

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EXHIBIT 10



SITE NUMBER: SP4359

> SITE NAME: OTHELLO DT ADDRESS: 640 E ELM ST

> > OTHELLO, WA 99344

FA#: 14084511

SITE TYPE: RAWLAND - 100' TRI-POLE

BELL TOWER


ZONING DRAWINGS

VICINITY MAP

FROM AT&T REDMOND, WA OFFICE:

- START OUT GOING NORTH ON 166TH AVE NE TOWARD NE 76TH ST. 0.09 MILES TAKE THE 3RD RIGHT ONTO CHECKLAND ST/WA-202. CONTINUE TO FOLLOW WA-202. WA-202 IS JUST PAST REDMOND CENTRAL CONN. 0.53 MILES MERGE ONTO WA-520 W. TOWARD SEATHLE. 5.85 MILES MERGE ONTO I-405 S TOWARD RENTON. 3.48 MILES MERGE ONTO I-90 E VIA EXIT 11 TOWARD SPOKANE. 128.48 MILES

- MERGE ONTO WA-26 E/HIGHWAY 26 W VIA EXIT 137 TOWARD OTHELLO/PULLMAN. 40.70 MILES TURN RIGHT ONTO RAMP.
- IF YOU ARE ON W HIGHWAY 26 AND REACH S REYNOLDS RD YOU'VE GONE ABOUT 0.9 MILES TOO FAR THEN 0.14 MILES
- TURN RIGHT ONTO S BROADWAY AVE/WA-24. CONTINUE TO FOLLOW S BROADWAY AVE. 1.04 MILES TURN RIGHT ONTO E MAIN ST.
- E MAIN ST IS JUST PAST E HEMLOCK ST
 IF YOU ARE ON N BROADWAY AVE AND REACH W CEDAR ST YOU'VE GONE A LITTLE TOO FAR THEN 0.50 MILES
- TURN RIGHT ONTO S 7TH AVE. 0.19 MILES
- PILGRIM LUTHERAN CHURCH, CNR ELM AND S 7TH AVE, OTHELLO, WA, IS ON THE RIGHT.

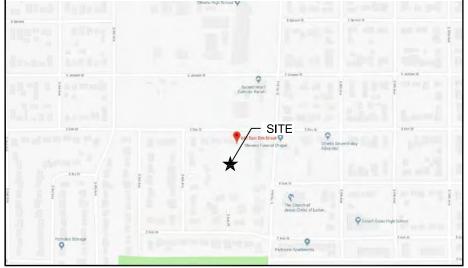

PROJECT CONTACT LIST

APPLICANT: AT&T MOBILITY RTC BUILDING 3 16221 NE 72nd WAY REDMOND, WA 98052

PROJECT CONSULTANT:

VELOCITEL LLC 4004 KRUSE WAY PLACE, STE 220 LAKE OSWEGO, OR 97035
CONTACT: BRAIN FLORES
PHONE: (503) 780–2847

SITE ACQUISTION AND PERMITTING:

PROJECT MANAGER:

VELOCITEL LLC 4004 KRUSE WAY PLACE, STE 220 VELOCITEL LLC 4004 KRUSE WAY PLACE, STE 220 LAKE OSWEGO, OR 97035 PHONE: (503) 636-2500 LAKE OSWEGO, OR 97035
CONTACT: JAMISON CAVALLARO, CFM (503) 636-2500 PHONE:

PROPERTY OWNER:

CONSTRUCTION MANAGER: PILGRIM LUTHERAN CHURCH 640 E ELM ST. OTHELLO, WA 99344

VELOCITEL LLC 4004 KRUSE WAY PLACE, STE 220 LAKE OSWEGO, OR 97035 CONTACT: MARK LINES PHONE: (541) 864-0818 mlinés@velocitel.com



AT&T MOBILITY RTC BUILDING 3 18221 NE 72nd WAY REDMOND, WA 98052



506 SECOND AVENUE, SUITE 1512 SEATTLE, WA 98104

PROJECT NO: 1802U022

DRAWN BY: NB

CHECKED BY: L.C.

CAD FILE: Z-1

SUBMITTALS

5 JUN 11/19 REVISED PER COMMENTS WT 4 JUN 11/19 REVISED PER COMMENTS WT MAY 16/19 REVISED PER COMMENTS WT FEB 20/19 REVISED PER COMMENTS JAN 24/19 REVISED PER COMMENTS JAN 11/19 FINAL ZD'S

THE INFORMATION CONTAINED IN THIS SET OF DOCUMENTS IS PROPRIETARY BY NATURE. ANY USE OR DISCLOSURE OTHER THAN THAT WHICH RELATES TO THE CLIENT NAMED IS STRICTLY PROHIBITED.

A OCT 29/18

REVISED PER COMMENTS

ISSUED FOR REVIEW

ASE SEAL

LEGAL DESCRIPTION

THAT PORTION OF THE SOUTHEAST QUARTER OF THE NORTHWEST QUARTER OF SECTION 3, TOWNSHIP 15 NORTH, RANGE 29 EAST W.M., DESCRIBED AS FOLLOWS:
BEGINNING AT THE INTERSECTION OF THE SOUTHERLY LINE OF ELM STREET AND THE NORTH—SOUTH CENTERLINE OF

SAID SECTION 3; THENCE WESTERLY ALONG SAID SOUTHERLY LINE 372 FEET; THENCE SOUTH 00°03°25" WEST 333
FEET MORE OR LESS TO A POINT ON THE CENTERLINE OF OAK STREET PRODUCED WESTERLY; THENCE EASTERLY
ALONG SAID CENTERLINE 360 FEET MORE OR LESS TO A POINT ON SAID NORTH—SOUTH CENTERLINE OF SECTION 3; THENCE NORTHERLY ALONG SAID CENTERLINE TO THE POINT OF BEGINNING.

SCALING DRAWINGS

SUBCONTRACTOR SHALL VERIFY ALL PLANS, EXISTING DIMENSIONS & CONDITIONS ON THE JOB SITE & SHALL IMMEDIATELY NOTIFY THE ENGINEER IN WRITING OF ANY DISCREPANCIES BEFORE PROCEEDING WITH THE WORK OR BE RESPONSIBLE FOR THE SAME.

IF USING 11"x17" PLOT, DRAWINGS WILL BE AT HALF SCALE.

APPROVAL / SIGN OFF OF ZONING DRAWINGS DATE SIGNATURE DATE SIGNATURE CONSULTANT GROUP SIGN OFF AT&T SIGN OFF CONSTRUCTION COORDINATOR COMPLIANCE LANDLORD'S REPRESENTATIVE CONSTRUCTION MANAGER PROJECT MANAGER DEPLOYMENT MANAGER SITE ACQUISITION EQUIPMENT ENGINEER ONING INTERCONNECT SITE ACQUISITION MANAGER **OPERATIONS** PERMITS RF ENGINEER RF ENGINEER MANAGER REVIEWERS SHALL CLEARLY PLACE INITIALS ADJACENT TO EACH REDLINE NOTE AS DRAWINGS ARE BEING REVIEWED

OTHELLO DT SP4359 640 E ELM ST OTHELLO, WA 99344


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SHEET TITLE

TITLE SHEET



TRUE NORTH ARROW SHOWN ON THIS DRAWING IS APPROXIMATE ONLY AND MUST BE VERIFIED E ELM ST.



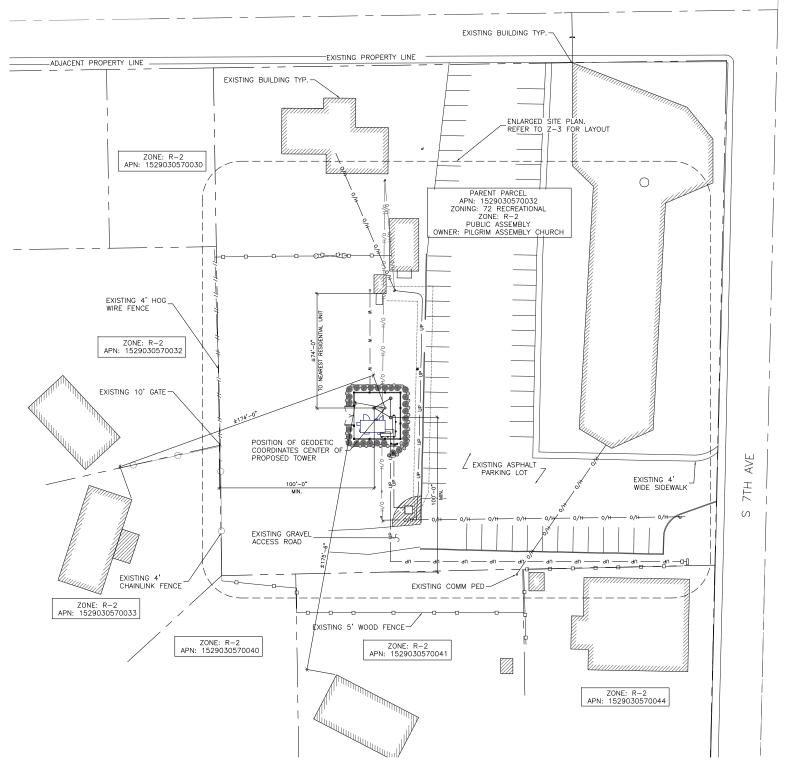

NOTES:

- INFORMATION OBTAINED FROM AN AERIAL PHOTOGRAPH AND SITE MEASUREMENTS TAKEN BY CORE ONE CONSULTING USA DATED OCT 01, 2018. THIS DRAWING DOES NOT REPRESENT A SURVEY.
- CONTRACTOR TO SITE VERIFY ALL DIMENSIONS AND CONDITIONS PRIOR TO CONSTRUCTION, REPORT ANY DISCREPANCIES TO THE ENGINEER.





4004 KRUSE WAY PLACE, SUITE 220 LAKE OSWEGO, OR 97035



506 SECOND AVENUE, SUITE 1512 SEATTLE, WA 98104

PROJECT NO: 1802U022

DRAWN BY: NR.

CHECKED BY: L.C.

CAD FILE: z-2

SUBMITTALS

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2	FEB	20/19	REVISED PER COMMENTS	
1	JAN	24/19	REVISED PER COMMENTS	
0	JAN	11/19	FINAL ZD'S	
В	NOV	14/18	REVISED PER COMMENTS	
Α	ОСТ	29/18	ISSUED FOR REVIEW	

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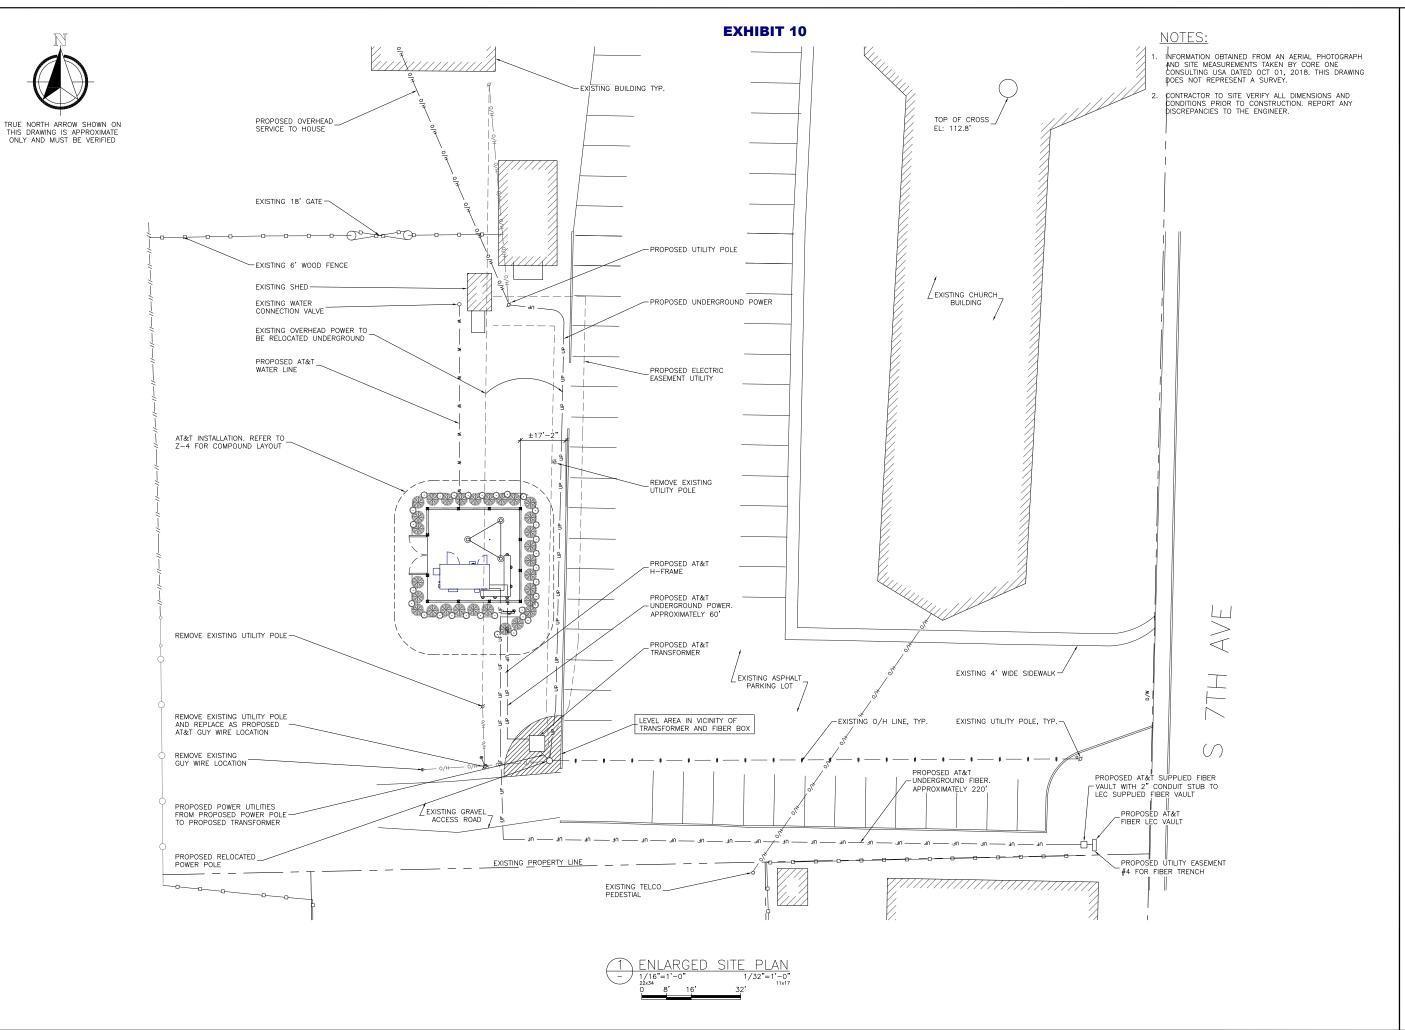
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OTHELLO DT SP4359 640 E ELM ST OTHELLO, WA 99344

FA#: 14084511

SHEET TITLE

SITE PLAN



at&t

AT&T MOBILITY RTC BUILDING 3 18221 NE 72nd WAY REDMOND, WA 98052



4004 KRUSE WAY PLACE, SUITE 220 LAKE OSWEGO, OR 97035



506 SECOND AVENUE, SUITE 1512 SEATTLE, WA 98104

PROJECT NO: 1802U022

DRAWNBY: NR.

CHECKED BY: L.C.

CAD FILE: Z-3

SUBMITTALS

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OTHELLO DT SP4359 640 E ELM ST OTHELLO, WA 99344

FA#: 14084511

SHEET TITLE

ENLARGED SITE PLAN



TRUE NORTH ARROW SHOWN ON THIS DRAWING IS APPROXIMATE ONLY AND MUST BE VERIFIED

NOTES:

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velocite

4004 KRUSE WAY PLACE, SUITE 220 LAKE OSWEGO, OR 97035



506 SECOND AVENUE, SUITE 1512 SEATTLE, WA 98104

PROJECT NO: 1802U022

DRAWN BY: N.R.

CHECKED BY: L.C.

CAD FILE: Z-4

SUBMITTALS

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	5	JUN	11/19	REVISED PER COMMENTS	WT
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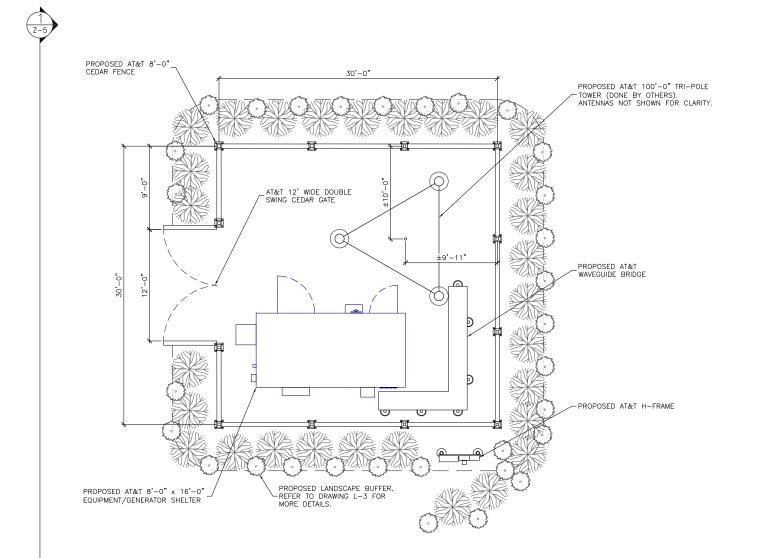
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FA#: 14084511

SHEET TITLE

COMPOUND LAYOUT



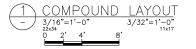


EXHIBIT 10

NOTES:

1. ELEVATION IS DIAGRAMMATIC ONLY.





4004 KRUSE WAY PLACE, SUITE 220 LAKE OSWEGO, OR 97035



506 SECOND AVENUE, SUITE 1512 SEATTLE, WA 98104

PROJECT NO: 1802U022

DRAWNBY: NR.

CHECKED BY: L.C.

CAD FILE: Z-5

SUBMITTALS

5	JUN 11/19	REVISED PER COMMENTS	WT
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2	FEB 20/19	REVISED PER COMMENTS	3
1	JAN 24/19	REVISED PER COMMENTS	5
0	JAN 11/19	FINAL ZD'S	
В	NOV 14/18	REVISED PER COMMENTS	5
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SITE


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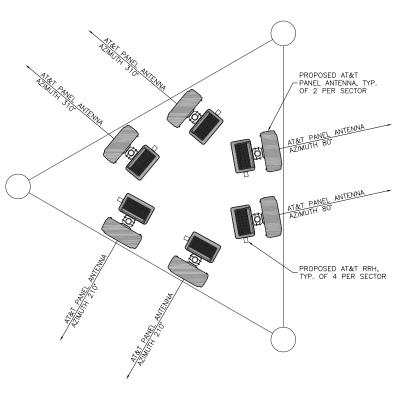
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WEST ELEVATION


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T.O. PROPOSED AT&T PANEL ANTENNA/TOWER 100'-0" A.G.L.

PROPOSED AT&T PANEL ANTENNA RAD CENTER ±96'-0" A.G.L.

FUTURE PANEL ANTENNA RAD CENTER ±86'-0" A.G.L.

WEST ELEVATION

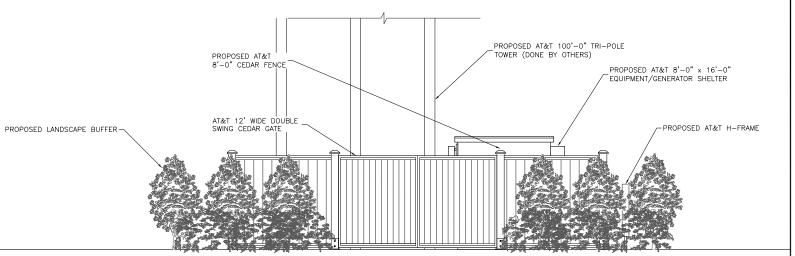- 1/8"=1'-0" 1/16"=1'-0" 1/16"=1'-0" 1/1117 0 16' 1117 0 16' 1117 0 16' 1117 0 16' 1117 0 16' 1117 0 16' 1117 0 16' 1117 0 16' 1117 0 16' 1117 0 16' 1117 0 16

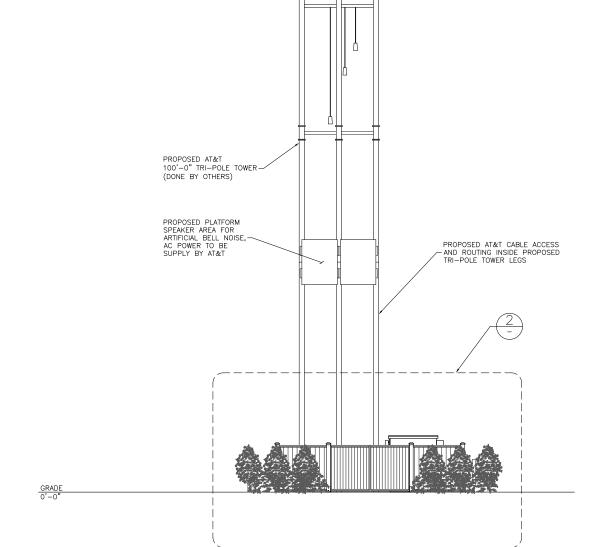SCOPE OF LANDSCAPING SUMMARY OF LANDSCAPING WORK:

- 1. PROTECTION AND PRESERVATION OF EXISTING TREES AND PLANTING DURING CONSTRUCTION.
- 2. SUPPLY AND INSTALLATION OF GROWING MEDIUM.
- 3. SUPPLY AND INSTALLATION OF PLANT MATERIAL
- 4. SUPPLY AND INSTALLATION OF AUTOMATIC IRRIGATION SYSTEM. INSURE GOOD COVERAGE FOR ALL PLANTING AREAS.
- 5. MAINTENANCE: PROVIDE ONE (1) FULL YEAR MAINTENANCE OF ALL LANDSCAPE AREAS, COMMENCING ON DATE OF SUBSTANTIAL COMPLETION.

VERIFICATION OF DIMENSIONS AND QUANTITIES:

1. BEFORE PROCEEDING WITH THE WORK, VISIT THE SITE AND CAREFULLY CHECK AND VERIFY DIMENSIONS AND QUANTITIES. REPORT VARIATIONS BETWEEN DRAWINGS AND SITE TO THE CONSULTANT BEFORE PROCEEDING WITH THE WORK.

QUALITY ASSURANCE:

- 1. LOCAL JURISDICTION NURSERY TRADES ASSOCIATION GUIDE SPECIFICATIONS FOR NURSERY STOCK SHALL APPLY
- 2. ALL LANDSCAPING AND PLANT MATERIAL SHALL BE IN ACCORDANCE WITH LOCAL JURISDICTION STANDARDS, CURRENT EDITION.
- 3. ALL MATERIALS SHALL BE OF THE QUALITY SPECIFIED OR ACCEPTABLE TO THE CONSULTANT. UNIT SAMPLES OF MATERIALS SHALL BE SUBMITTED UPON THE REQUEST OF THE CONSULTANT.

GUARANTEE:

1. GUARANTEE THE WORK AND MATERIALS FOR A PERIOD OF ONE (1) YEAR FROM THE DATE OF SUBSTANTIAL PERFORMANCE.

DELIVERY AND STORAGE OF MATERIALS:

- ALL MANUFACTURED MATERIALS, SUCH AS FERTILIZER, BONEMEAL, MULCHES, ETC., SHALL BE DELIVERED TO, AND STORED ON THE SITE IN STANDARD CONTAINERS CLEARLY INDICATING CONTENTS, WEIGHT, ANALYSIS, AND NAME OF THE MANUFACTURER.
- ALL MATERIALS WHICH ARE SUBJECT TO DETERIORATION RESULTING FROM WEATHER, OR ANY OTHER CAUSES, SHALL BE STORED ON THE SITE IN A DRY WEATHERPROOF PLACE IN SUCH A MANNER THAT THEIR EFFECTIVENESS WILL NOT BE IMPAIRED.

SHRUB AND TREE PRESERVATION GENERAL:

 FURNISH ALL TREE PROTECTION, WATERING, FERTILIZING, AND PRESERVING ROOT SYSTEMS AFFECTED BY CHANGING GRADES OR CONSTRUCTION. THIS WORK IS TO BE DONE BY AN APPROVED LANDSCAPE CONTRACTOR, PRIOR TO COMMENCING ANY WORK ON THE SITE.

PRODUCTS:

- 1. FERTILIZER: COMPLETE COMMERCIAL SLOW RELEASE FERTILIZER (10-6-4 OR APPROVED TYPE) WITH 50% OF ELEMENTS DERIVED FROM ORGANIC SOURCES.
- 2. WATER: POTABLE TYPE

EXECUTION:

- 1. UNDER SUPERVISION OF THE CONSULTANT, RETAIN AND PROTECT ALL EXISTING TREES AND SHRUBS AS INDICATED ON THE DRAWINGS, AND IDENTIFIED ON THE SITE.
- 2. TREE PROTECTION SHALL BE PLACED BEFORE ANY CONSTRUCTION OR GRADING IS BEGUN AND SHALL BE MAINTAINED IN REPAIR FOR THE DURATION OF THE CONSTRUCTION WORK.
- 3. ENCASE THE AREA OUTSIDE THE DRIPLINE WITH CHAIN LINK FENCING AND METAL POSTS. METAL POSTS MUST BE SET 915mm INTO THE GROUND AND AT INTERVALS OF NOT MORE THAN 1829mm O.C, OR AS SHOWN ON THE DRAWINGS.
- 4. PROTECT ROOTS OF DESIGNATED TREES TO DRIPLINE TO PREVENT DISTURBANCE OR DAMAGE. AVOID TRAFFIC AND DUMPING AND STORAGE OF MATERIALS OVER ROOT ZONES. NO MATERIAL SHALL STORED WITHIN 12m OF ANY TREE DESIGNATED TO BE SAVED.
- 5. TREE PROTECTION IS TO REMAIN UNTIL THE PLANTING WORK IS STARTED, AND THEN REMOVED.
- 6. PLANT MATERIAL WITHIN THE PROTECTION AREAS THAT HAS BEEN DAMAGED BEYOND REPAIR BY THE CONTRACTOR SHALL BE REPLACED BY THE CONTRACTOR WITH THE SAME SPECIES AND GROWTH AT NO COST TO THE OWNER.

FERTILIZING EXISTING TREES:

- 1. APPLY COMPLETE FERTILIZER AT THE RATE SPECIFIED ON THE CONTAINER TO ALL TREES TO BE RETAINED. APPLY FERTILIZER WHEN FENCING IS ERECTED, AND ONCE AGAIN EARLY IN THE GROWING SEASON.
- 2. DISTRIBUTE FERTILIZER EQUALLY INTO HOLES DRILLED 8 -10 IN. DEEP SPACED 2'-0"-2'-6" APART, IN A CIRCULAR PATTERN WITHIN THE DRIPLINE OF EACH TREE TO BE RETAINED.
- 3. WATER THOROUGHLY AFTER FERTILIZER IS APPLIED. WATER ALL TREES TO BE RETAINED THROUGHOUT THE CONSTRUCTION PERIOD TO ENSURE THAT ROOTS ARE NEVER DRY. SOAK AREA IMMEDIATELY BELOW TREE CROWN SUFFICIENTLY DEEP TO REACH FEEDER ROOTS.

GROWING MEDIUM PREPARATION AND EXHIBITENT GENERAL:

- WORK INCLUDED: FURNISH ALL LABOUR, MATERIALS, AND EQUIPMENT NECESSARY FOR THE PREPARATION AND PLACEMENT OF THE GROWING MEDIUM, DRAINAGE COURSE, FILTER FABRIC AND CLEAN-OUTS.
- 2. DEFINITIONS: FOR THE PURPOSES OF THIS SPECIFICATION, THE TERM "GROWING MEDIUM" SHALL MEAN A COMPOSITION OF THE VARIOUS BASIC MATERIALS AND FERTILIZERS FOR SUPPORTING HEALTHY PLANT GROWTH.
- 3. EXISTING CONDITIONS:
 - EXAMINE EXISTING SUBGRADE CONDITIONS AND SIGNIFY ACCEPTANCE IN WRITING TO THE CONSULTANT.
 - ASCERTAIN THE SIZE AND LOCATION OF ALL EXISTING SERVICES AND SUBGRADES PRIOR TO THE WORK
 - REPAIR DAMAGE RESULTING FROM FAILURE TO EXERCISE SUCH PRECAUTIONS IMMEDIATELY AT NO COST TO THE OWNER.
- 4. TESTING: THE LANDSCAPE SUBCONTRACTOR IS RESPONSIBLE FOR TESTING THE ONSITE AND IMPORTED TOPSOIL. SOIL TEST SHALL INCLUDE MEASURABLE PHYSICAL AND CHEMICAL PROPERTIES. THE TEST SHALL DETERMINE THE ANALYSIS AND QUANTITY OF FERTILZER, LIME (IF REQUIRED) AND/OR OTHER ADDITIVES TO BE USED TO BRING IT TO A SATISFACTORY CHEMICAL AND PHYSICAL CONDITION. BEFORE ADJUSTING THE TOPSOIL AS REQUIRED BY THE SOILS TESTING, SUBMIT SOILS ANALYSIS TO THE CONSULTANT FOR APPROVAL. CONTRACTOR SHALL BEAR ALL COSTS INCURRED BY SOIL ANALYSIS FOR SOIL RECOMMENDATION AND TESTING.
- 5. PRODUCT HANDLING:
 - ALL MATERIALS TO BE HANDLED AND ADEQUATELY PROTECTED TO PREVENT DAMAGE.
 - STOCKPILE MATERIALS IN BULK FORM IN PAVED AREAS. PROVIDE ADDITIONAL PROTECTION OF STORAGE UNDER ROOF OR TARPAULINS FOR BULK FORMS OF PEAT MOSS. TAKE PRECAUTIONS TO PREVENT CONTAMINATION OF BASIC MATERIALS FROM WINDBLOWN SOIL PARTICLES, WEED SEEDS, AND FROM INSECTS. CONTAMINATION OF THE INGREDIENTS MAY RESULT IN THEIR REJECTION FOR USE.
 - · STORE FERTILIZER AND CHEMICAL INGREDIENTS IN THE MANUFACTURER'S ORIGINAL CONTAINERS.
- 6. STORAGE OF FINISHED GROWING MEDIUM: STORE GROWING MEDIUM IN A DRY AREA AND PROTECTED FROM CONTAMINATION, DAMAGE, AND THE ELEMENTS.
- INSPECTION: NOTIFY THE CONSULTANT AT LEAST FOURTY-EIGHT (48) HOURS PRIOR TO SOIL PLACEMENT TO INSPECT TOPSOIL.

MATERIALS:

- 1. ON SITE SOIL
 - ON SITE SOIL MAY BE USED, PROVIDED THAT IT MEETS THE STANDARDS SET FOR IMPORTED SOIL WHEN EVALUATED THROUGH SOIL ANALYSIS AND/OR CAN BE REASONABLY MODIFIED TO MEET THE REQUIREMENTS SET OUT FOR THE GROWING MEDIUM. ON SITE SOIL SHOULD NOT BE ASSUMED TO ACCEPTABLE FOR THE PROJECT WITHOUT A LABORATORY ANALYSIS. NATIVE TOPSOIL SHOULD BE STOCKPILED ON THE SITE IN AREAS DESIGNATED FOR THIS PURPOSE IN THE CONSTRUCTION PLAN.

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 - ALL AREAS DESIGNATED FOR PAVING, OR THE CONSTRUCTION OF STRUCTURES, SHALL BE STRIPPED OF ALL TOPSOIL AND ORGANIC MATTER. WHENEVER FEASIBLE, THE CONTRACTOR WILL AVOID HARVESTING TOPSOIL. WHILE IT IS NOT CONSIDERED A NECESSITY, IT WOULD BE A BENEFIT TO COVER STOCKPILES WITH PLASTIC OR CANVAS TO MAINTAIN DRY SOIL CONDITIONS.
 - TOPSOIL SHALL BE STRIPPED TO ITS FULL DEPTH AS DETERMINED BY A QUALIFIED SOIL SCIENTIST (OR APPROVED EQUIVALENT), OBSERVING APPROPRIATE CARE NOT TO MIX TOPSOIL AND SUBSOIL. SUBSOIL MAY BE STORED SEPARATELY FROM THE TOPSOIL IN THE EVENT THAT IT MAY BE UTILIZED FOR THE PROJECT. STOCKPILED TOPSOIL AND SUBSOIL SHOULD BE ANALYZED SEPARATELY IF BOTH ARE TO BE USED FOR THE PROJECT.
 - TOPSOIL STRIPPING SHALL COMMENCE AFTER THE AREA HAS BEEN CLEARED OF ALL SHRUBS, PLANTS, WEEDS, GRASS, STUMPS, ROCKS (102mm AND LARGER), AND ANY OTHER EXTRANEOUS MATERIALS NOT POSITIVELY CONTRIBUTING TO THE FINISHED PROJECT. THE ABOVE LISTED WASTE MATERIALS SHOULD BE REMOVED FROM THE SITE.

GROWING MEDIUM PREPARATION AND PLACEMENT CONT MATERIALS:

- 1. IMPORTED TOPSOIL
 - IT IS IMPORTANT AT THIS POINT TO DIFFERENTIATE IMPORTED TOPSOIL FROM IMPORTED SOIL PREPARATIONS. TOPSOIL IS A NATURAL RESOURCE RESULTING FROM THE INTERACTION OF MINERAL PARENT MATERIALS, VEGETATION, CLIMATE, SOURCE TOPOGRAPHY, AND A TIME FACTOR. SOIL PREPARATIONS ARE MAN—MADE PRODUCTS OF MIXING MINERAL AND ORGANIC COMPONENTS. THE PREPARATIONS ARE OFTEN LARGELY COMPOSED OF SAND AND PEATS MIXED AMNUALLY BUT DISPLAYING LITTLE OR NO STRUCTURAL DEVELOPMENT AND FOR ALL INTENTS AND PURPOSES, NO TIME FACTOR. FOR THE ABOVE REASON, THIS LIST OF SPECIFICATIONS DOES NOT REFER TO SOIL PREPARATIONS AS TOPSOIL. SOIL PREPARATION MAY BE VIEWED AS THE BEST POTENTIAL SUBSTITUTE AVAILABLE FOR THE LIMITED RESOURCE TERMED TOPSOIL.
 - IT IS FEASIBLE THAT AN IMPORTED SOIL COULD BE TOPSOIL. IN THIS SITUATION A PRECISE LOCATION AND BRIEF HISTORY OF THE TOPSOIL WOULD PROVIDED BY THE SUPPLIER. THE PURPOSE OF THE BRIEF HISTORY OF THE TOPSOIL IS TO AVOID HARVESTING OF SOIL WHICH MAY HAVE SUPPORTED UNDESIRABLE PLANT SPECIES (IE. CRABGRASS, COUCHGRASS, EQUISETUM, NOXIOUS WEEDS) AND/OR THEIR DEPOSITED SEEDS OR MAY HAVE BEEN IN CONTACT WITH UNDESIRABLE TOXIC MATERIALS (HERBICIDES, INSECTICIDES, OILS, FUELS, ETC.).
 - NATURAL, FERTILE, AGRICULTURAL SOIL, CAPABLE OF SUSTAINING VIGOROUS PLANT GROWTH. OF UNIFORM COMPOSITION THROUGHOUT, WITHOUT ADMIXTURE OF SUBSOIL. FREE OF STONES, LUMPS, LIVE PLANTS AND THEIR ROOTS, STICKS, AND OTHER EXTRANEOUS MATTER.
 - ACIDITY RANGE OF PH 5.0 TO PH 7.0 CONTAINING NOT LESS THAN SIX PERCENT (6%) ORGANIC MATTER.
- PEAT MOSS: DECOMPOSED FIBROUS CELLULAR STEMS AND LEAVES OF SPECIES OF SPHAGNUM MOSSES
 CONSISTING OF A MINIMUM OF 90%ORGANIC MATTER BY DRY WEIGHT BASIS, FINELY GROUND TO ENABLE
 MIXING WITH OTHER COMPONENTS; 100% BY VOLUME OF THE PARTICLE SIZES TO PASS A #4 SIEVE WITH A
 MINIMUM OF 97.5% PASSING A #8 SIEVE.
- 3. PUMICE: A GROUND POROUS VOLCANIC ROCK, DARK BROWN TO BLACK IN COLOUR.
- 4. MUSHROOM MANURE: WELL-ROTTED, UNLEACHED MUSHROOM MANURE, FREE OF WEEDS, SALT, AND NOXIOUS SUBSTANCES. PROVIDE A SAMPLE TO PACIFIC SOIL ANALYSIS FOR INSPECTION AND APPROVAL. APPROVED SAMPLE SHALL BE STANDARD THROUGHOUT.
- 5. PUMP RIVER SAND: SAND SHALL BE PUMPED FROM A RIVER AND FREE OF SALT, DEBRIS, WEEDS AND TOXIC CHEMICALS. SAND SHALL BE 50%MEDIUM AND 50% COURSE SAND. PROVIDE A SAMPLE TO PACIFIC SOIL ANALYSIS FOR INSPECTION AND APPROVAL. APPROVED SAMPLE SHALL BE STANDARD THROUGHOUT.
- FERTILIZER AND CHEMICAL INGREDIENTS: LIST AVERAGE P.P.M. OF PRIMARY NUTRIENTS WHERE APPLICABLE FINELY GROUND, GRANULAR OR WATER SOLUBLE FORM TO PERMIT THEIR UNIFORM DISTRIBUTION THROUGHOUT THE MIX.
 - NITROGEN FERTILIZER: 50% OF TOTAL NITROGEN DERIVED FROM A NATURAL ORGANIC MATERIAL IN A SLOW RELEASE FORM.
 - BONEMEAL: FINELY GROUND COMMERCIAL RAW BONEMEAL WITH MINIMUM 4% NITROGEN AND MINIMUM OF 20% PHOSPHORIC ACID.
 - NUTRICOTE (BY AGRICO): 16-10-10.
- 8. DRAINAGE AND FILTER:
 - DRAIN ROCK: 3/"-1" DIAMETER ROUND ROCK WASHED FREE OF ALL FINES AND ORGANIC MATERIALS.
 - FILTER FABRIC: HEAT BONDED, ROT-PROOF, NON-WOVEN FABRIC, OR APPROVED EQUAL.
- $9. \quad \text{CLEANOUTS: 152mm DIAMETER PVC PIPE, LENGTHS AS REQUIRED. 6"DIAMETER PVC CAPS, BLACK IN COLOUR.}$
- 10. FEEDER TUBES: 102mm DIAMETER PVC PIPE, LENGTHS AS REQUIRED

GROWING MEDIUM PREPARATION AND PLACEMENT CONT. EXECUTION:

- GROWING MEDIUM AMENDMENTS: GROWING MEDIUMS SHALL VARY ACCORDING TO PLANTING AREAS AND ACCORDING TO
 PACIFIC SOIL ANALYSIS RECOMMENDATIONS. APPROXIMATE VOLUMES ONLY.
 - SOD AREAS: BY VOLUME 80% SAND MIX, 10% SOIL, 10%MUSHROOM MANURE TO BE SPREAD 51mm DEEP OVER SAND AND SOIL MIX, DIG INTO TOP 4"OF SAND AND SOIL MIX. ADD FERTILIZER AND OTHER AMENDMENTS AS SPECIFIED BY SOIL CONSULTANT.
 - TREE AND SHRUB AREAS: BY VOLUME 60% SAND MIX, 20%TOPSOIL, 20% MUSHROOM MANURE TO BE SPREAD 6°DEEP LAYER OVER SAND AND SOIL MIX. ADD FERTILIZER AND OTHER AMENDMENTS AS SPECIFIED BY SOIL CONSULTANT.
- 2. PLACEMENT ON GRADE:
 - CULTIVATE ENTIRE SUBGRADE TO A DEPTH OF 12" IMMEDIATELY PRIOR TO PLACEMENT OF THE GROWING MEDIUM.
 - NO GROWING MEDIUM SHALL BE LOADED, TRANSPORTED, OR SPREAD WHEN IT IS SO WET THAT ITS STRUCTURE IS LIKELY TO BE ALTERED.
 - PLACE GROWING MEDIUM TO THE FOLLOWING DEPTHS:
 - GROUNDCOVER AREAS 1'-5"
 - SHRUB AREAS 1'-5"
- LAWN AREAS 1'-0"
- FINE GRADE GROWING MEDIUM TO FINISH GRADES SHOWN ELIMINATING ROUGH SPOTS AND LOW AREAS TO ENSURE POSITIVE DRAINAGE. PREPARE LOOSE FRIABLE BEDS BY MEANS OF DISCING AND SUBSEQUENT RAKING.
- CLEANOUTS:
- CUT V-SHAPED NOTCHES AT ONE END OF 6"DIAMETER PVC PIPE. PLACE NOTCHED END OVER ROOF DRAIN, SURROUND WITH 2"DEPTH DRAIN ROCK AND RUN FILTER FABRIC 8"UP AROUND PIPE.
- ENSURE TOP OF PIPE IS FLUSH WITH FINISH GRADE AND COVER WITH PVC CAP, BLACK IN COLOUR.



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PROJECT NO: 1802U022

DRAWNBY: WT

CHECKED BY: LC.

CAD FILE: L-1

SUBMITTALS

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ASE SEAL

CITC

OTHELLO DT SP4359 640 E ELM ST OTHELLO, WA 99344

FA#: 14084511

SHEET TITLE

LANDSCAPE NOTES I

SHEET NOW

L-1

PLANTS AND PLANTING GENERAL:

- QUALITY ASSURANCE: ALL MATERIALS AND EXECUTION TO CONFORM TO THE LATEST EDITION OF THE FOLLOWING STANDARDS OR AS OTHERWISE SPECIFIED.
 - . LOCAL JURISDICTION GUIDE SPECIFICATIONS FOR NURSERY STOCK.
 - LOCAL JURISDICTION GUIDE SPECIFICATIONS FOR LANDSCAPE
 CONSTRUCTION
- 2. SUBMITTALS: SUBMIT INSPECTION CERTIFICATES AS REQUIRED BY LAW FOR EACH SHIPMENT OF PLANT MATERIAL.
- 3. DELIVERY AND STORAGE:
 - DIG AND HANDLE ALL PLANT MATERIAL IN A MANNER SUITABLE FOR EACH SPECIES TO PREVENT INJURY TO OR REMOVAL OF FIBROUS ROOTS. ALL PLANT MATERIAL ARRIVING ON SITE WITH BROKEN OR LOOSE ROOT BALLS WILL BE REJECTED. TAKE PRECAUTIONS TO AVOID BURNING OF PLANTS BY SUN OR WIND DURING HANDLING AND SHIPPING
 - KEEP ROOT BALLS AND CONTAINER SOIL MOIST BEFORE PLANTING BY COVERING WITH BARK MULCH OR SOIL. PROTECT FERTILIZER AGAINST MOISTURF.

4. PROTECTION:

- VERIFY EXISTENCE AND LOCATION OF ANY ON—SITE UTILITIES. CONSULT THE CONSULTANT IMMEDIATELY FOR DIRECTIONS AS TO PROCEDURE SHOULD ANY PIPING OR UTILITIES BE ENCOUNTERED DURING EXCAUSITION
- PROTECT EXISTING BUILDINGS, EQUIPMENT, SIDEWALKS, LANDSCAPING REFERENCE POINTS, MONUMENTS AND MARKERS. MAKE GOOD ALL DAMAGE INCURRED DURING THIS WORK.
- MAKE EVERY EFFORT TO PROTECT PLANTS ADJACENT TO ANY CONSTRUCTION WORK
- ERECT TEMPORARY CONTINUOUS BARRIERS WHERE NECESSARY TO ENSURE SAFETY OF EXISTING PLANTS AND TREES AS SHOWN ON THE DRAWINGS, OR AS REQUIRED.
- REPLACE, AT NO EXPENSE TO THE OWNER, ANY TREES AND PLANT MATERIAL DAMAGED

5. INSPECTION

- MAKE ALL PLANT MATERIAL AVAILABLE AT ONE LOCATION 12 MONTHS AND ALSO TEN (10) DAYS PRIOR TO SCHEDULED PLANTING TIME FOR INSPECTION BY THE CONSULTANT.
- NOTIFY THE CONSULTANT WHEN THE PLANTS ARE AVAILABLE FOR INSPECTION. ALL PLANTS ARE SUBJECT TO INSPECTION AND MAY BE REJECTED FOR FAILURE TO COMPLY WITH THIS SPECIFICATION AT ANY TIME UNTIL TOTAL PERFORMANCE. REPLACE REJECTED PLANT MATERIAL AND REMOVE FROM THE SITE AT NO COST TO THE OWNER.
- NOTIFY THE CONSULTANT AT THE COMPLETION OF THE WORK FOR AN INSPECTION FOR SUBSTANTIAL PERFORMANCE.
- FINAL INSPECTION OF ALL PLANTING WILL BE MADE AT THE END OF THE SPECIFIED GUARANTEE PERIOD. FOR RELEASE FROM THE CONTRACT, ALL PLANT MATERIALS SUPPLIED OR TRANSPLANTED BY THE CONTRACTOR MUST BE ALIVE AND IN A HEALTHY, SATISFACTORY GROWING CONDITION AT THE TIME OF THE INSPECTION. FOR SPECIFIED PLANT, THE CONSULTANT RESERVES THE RIGHT TO EXTEND THE CONTRACTOR'S RESPONSIBILITY FOR ANOTHER GROWING SEASON, IF IN HIS OR HER OPINION, LEAF DEVELOPMENT AND GROWTH IS NOT SUFFICIENT TO ENSURE SATISFACTORY FUTURE GROWTH.
- THE CONSULTANT AT HIS DISCRETION MAY WAIVE ONE OR MORE INSPECTIONS, BUT THIS SHALL NOT IMPAIR THE RIGHT OF THE CONSULTANT TO INSPECT WORK OR MATERIALS WHICH HAVE BEEN DAMAGED OR IN ANY WAY DO NOT CONFORM TO THE SPECIFICATIONS.
- THE CONTRACTOR OR HIS AUTHORIZED REPRESENTATIVE SHALL BE PRESENT DURING ALL REQUIRED INSPECTIONS AS SPECIFIED OR AS MAY BE REQUIRED BY THE CONSULTANT.

6. REPLACMENT

- REPLACE ALL PLANT MATERIAL FOUND DEAD, OR NOT IN A HEALTHY, SATISFACTORY GROWING CONDITION OR WHICH, IN ANY OTHER WAY, DO NOT MEET THE REQUIREMENTS FOR THE SPECIFICATIONS, AT OWN EXPENSE, WHERE MAINTENANCE DURING THE GUARANTEE PERIOD IS THE RESPONSIBILITY OF THE CONTRACTOR.
- THE COST OF REPLACEMENTS RESULTING FROM THEFT, ACCIDENTAL DAMAGE, VANDALISM, CARRLESSNESS OR NEGLECT ON THE PART OF OTHERS, OR ANY OTHER CAUSE DUE TO CIRCUMSTANCES BEYOND THE CONTROL OF THE CONTRACTOR, SHALL BE BORNE BY THE OWNER.
- REQUIRED REPLACEMENTS SHALL BE PLANTS AT THE SAME SIZE AND SPECIES AS SPECIFIED ON THE PLANT LIST AND SHALL BE SUPPLIED AND PLANTED IN ACCORDANCE WITH THE DRAWINGS, SPECIFICATIONS, AND CHANGE ORDERS THERETO.
- REPLACE EACH DEFECTIVE OR DEAD PLANT DURING THE NEXT PLANTING SEASON AND CONTINUE TO REPLACE EACH PLANT UNTIL IT HAS ESTABLISHED ITSELF TO THE SATISFACTION OF THE CONSULTANT.

<u>PLANTS AND PLANTING CONT.</u> GENERAL:

7. SUBSTITUTIONS: IF IT IS IMPOSSIBLE TO OBTAIN THE PARTICULAR PLANT MATERIAL LISTED ON THE LANDSCAPE PLAN, THE CONTRACTOR MAY BE PERMITTED TO SUGGEST SUBSTITUTIONS WITH TYPES AND VARIATIONS POSSESSING THE SAME CHARACTERISTICS. THE CONTRACTOR MUST REQUEST ANY SUBSTITUTIONS IN WRITING AT LEAST TWELVE (12) MONTHS PRIOR TO PLANTING. SUBSTITUTIONS MUST BE APPROVED BY THE CONSULTANT.

8. MAINTENANCE:

- THE MAINTENANCE PERIOD BEGINS AT THE DATE OF INSTALLATION AND CONTINUES UNTIL THE DATE OF SUBSTANTIAL PERFORMANCE.
- MAINTENANCE INCLUDES NECESSARY WATERING, CULTIVATION, WEEDING, PRUNING, MOWING, AERATING, DISEASE AND INSECT CONTROL, PROTECTIVE SPRAYING, REPLACEMENT OF UNACCEPTABLE MATERIAL, STRAIGHTENING PLANTS WHICH LEAN OR SAG, ADJUSTMENT OF PLANTS WHICH SETTLE OR ARE PLANTED TOO LOW, AND ANY OTHER PROCEDURES CONSISTENT WITH GOOD HORTICULTURAL PRACTICE NECESSARY TO INSURE NORMAL, VIGOROUS AND HEALTHY GROWTH OF ALL WORK UNDER THIS CONTRACT.
- MAINTAIN ALL ACCESSORIES SUCH AS TREE STAKES, ETC., IN GOOD CONDITION, INCLUDING ADJUSTMENT, AND REPAIR OR REPLACE ALL SUCH ACCESSORIES WHEN REQUIRED.
- 9. AREA OF PLANT SUPPLY AND SEARCH: BEFORE SUBSTITUTIONS OF PLANT MATERIAL ARE PROPOSED, PROOF THAT MATERIALS ARE NOT AVAILABLE THROUGH SEARCH ON THE WEST COAST OF CANADA AND THE UNITED STATES MUST BE PROVIDED. AREA OF SUPPLY SHALL INCLUDE BUT NOT BE LIMITED TO THE AREA AS MENTIONED HEREIN.

10. DELIVERY AND STORAGE:

- DIG AND HANDLE ALL PLANT MATERIAL IN A MANNER SUITABLE FOR EACH SPECIES TO PREVENT INJURY TO OR REMOVAL OF FIBROUS ROOTS. ALL PLANT MATERIAL ARRIVING ON SITE WITH BROKEN OR LOOSE ROOT BALLS WILL BE REJECTED. TAKE PRECAUTIONS TO AVOID BURNING OF PLANTS BY SUN OR WIND DURING HANDLING AND SHIPPING.
- KEEP ROOT BALLS AND CONTAINER SOIL MOIST BEFORE PLANTING BY COVERING WITH BARK MULCH OR SOIL. PROTECT FERTILIZER AGAINST MOISTURE.

PRODUCTS: PLANT MATERIAL:

- OF SIZES AND QUANTITIES SHOWN IN PLANT LISTS ON LANDSCAPE DRAWINGS AND SPECIFICATION: NURSERY GROWN.
- 2. CONFORM TO THE LOCAL JURISDICTION NURSERY TRADES ASSOCIATION "GUIDE SPECIFICATION FOR NURSERY STOCK". IN PARTICULAR:
 - "NURSERY STOCK SHALL BE TRUE TO NAME, AND OF THE SIZE OR GRADE STATED." $\,$
 - "QUALITY SHALL BE NORMAL FOR THE SPECIES WHEN GROWN UNDER PROPER CULTURAL CONDITIONS...VIABLE, SUBSTANTIALLY FREE FROM PESTS AND DISEASE, AND UNDAMAGED."
 - "ROOTS SHALL NOT BE SUBJECT TO LONG EXPOSURE TO DRYING WINDS, SUN OR FROST, BETWEEN DIGGING AND DELIVERY."
 - "ROOT BALLS SHALL BE FREE FROM PERNICIOUS PERENNIAL WEEDS"
- TRANSPLANTED OR ROOT PRUNED AT LEAST ONCE WITHIN THE YEAR PRIOR TO PLANTING.
- 4. TAKE PRECAUTIONS DURING DIGGING, HANDLING, AND SHIPPING OF PLANT MATERIAL TO AVOID INJURY TO PLANTS AND ROOT SYSTEMS.
- ALL PLANTS: TYPICAL OF THEIR SPECIES OR VARIETY, HAVE A NORMAL HABIT OF GROWTH, AND SHALL BE FIRST QUALITY, SOUND, HEALTHY, VIGOROUS, WELL—BRANCHED, AND DENSELY FOLIATED, FREE OF DISEASE, INSECT PESTS, EGGS OR LARVAE, HEALTHY, WELL—FURNISHED ROOT
- 6. CONFORM TO THE MEASUREMENTS SPECIFIED IN THE PLANT LIST.
 MEASUREMENTS SPECIFIED ARE THE MINIMUM ACCEPTABLE FOR EACH
 VARIETY. PLANTS THAT MEET THE REQUIREMENTS SPECIFIED IN THE
 ITEMIZED PLANT LIST, BUT DO NOT POSSESS A NORMAL BALANCE BETWEEN
 HEIGHT AND SPREAD WILL NOT BE ACCEPTED. PLANTS FOR USE WHEN
 SYMMETRY IS REQUIRED, OR WHEN PLANTED IN FORMAL ROWS, SHALL BE
 MATCHED IN FORM AND SIZE AS NEARLY AS POSSIBLE. DO NOT PRUNE
 PRIOR TO DELIVERY.
- 7. ALL PLANTS AND TREE TRUNKS SHALL BE MEASURED WHEN THE BRANCHES ARE IN THE NORMAL POSITION. DIMENSIONS FOR HEIGHT AND SPREAD AS CONTAINED HEREIN REFER TO THE MAIN BODY OF THE PLANT AND NOT FROM BRANCH—TIP TO BRANCH—TOP. THE HEIGHT OF TREE TRUNKS NEED NOT BE AS SPECIFIED IF THE REQUIRED HEIGHT CAN BE OBTAINED BY PRUNING THE LOWER BRANCHES WITHOUT LEAVING UNSIGHTLY SCARS OR OTHERWISE DAMAGING THE TRUNK. DO NO PRUNING OF BRANCHES TO OBTAIN THE REQUIRED HEIGHT BEFORE THE PLANTS ARE DELIVERED TO THE SITE UNLESS SO APPROVED IN WRITING BY THE CONSULTANT.
- 8. ALL TREES MUST HAVE STRAIGHT TRUNKS WITH A SINGLE LEADER INTACT.
 THERE SHALL BE NO ABRASION OF THE BARK, AND NO FRESH CUTS OF
 LIMBS OVER 30MM WHICH HAVE NOT COMPLETELY CALLOUSED OVER.

PLANTS AND PLANTING CONT. RELATED MAILTINGS:

- 1. TREE STAKES: DRESSED 4 SIDES 2"x2" TREATED FIR STAKES, LENGTHS AS
- TREE TIES AND GUYWIRES: .10 DIAMETER GALVANIZED WIRE, COVERED WITH NEW BLACK GARDEN HOSE, 2—PLY, REINFORCED AND AT LEAST 15/32" DIAMETER, OR APPROVED EQUAL.
- 3. MULCH: PEAT MOSS
- 4. FASTENERS: ALL FASTENERS TO BE HOT DIPPED GALVANIZED.
- PLANTING TABLETS: PROLONGED-RELEASE FERTILIZER TABLETS CONTAINING 20% NITROGEN, 10% PHOSPHORIC ACID, AND 5% POTASH (20-10-5). AGRIFORM OR PRE-APPROVED EQUIVALENT. STORE IN WEATHERPROOF STORAGE SPACE.

EXECUTION:

- 1. TREE PITS ON GRADE: OF THE FOLLOWING MINIMUM STANDARD.
 - TWO TIMES THE DIAMETER OF THE ROOT BALL WITH THE TREE IN THE CENTER OF THE PIT
 - 1'-0" DEEPER THAN THE ROOT BALL FOR THE ENTIRE TREE PIT.

2. PLANTING SEASON:

- PLANT ONLY DURING THE SEASON OR SEASONS WHICH ARE NORMAL FOR SUCH WORK DETERMINED BY WEATHER CONDITIONS AND AS APPROVED BY THE CONSULTANT.
- DO NOT PLANT DURING FREEZING AND/OR ABNORMALLY HOT, DRY
 WEATHER

3. PLANT LAYOUT:

- LOCATES PLANTS ACCORDING TO THE PLANTING PLAN, AND ACCORDING TO LOCATIONS DETERMINED BY THE CONSULTANT, FOR APPROVAL OF PLANT LOCATIONS AND ORIENTATION. THE CONSULTANT MAY MAKE ADJUSTMENTS IN PLANT LOCATIONS AND ORIENTATION PRIOR TO PLANTING.
- STAKE LOCATION OF ALL MAJOR TREES FOR APPROVAL PRIOR TO POSITIONING. REQUEST CONSULTANT TO BE PRESENT DURING PLANTING OF MAJOR TREES TO ENSURE PROPER ORIENTATION AND LOCATION.

4. PLANTING PROCEDURE:

- ALL PLANTS TO BE INSTALLED MAINTAINING ORIGINAL GRADES OF BASES AS IN THE NURSERY.
- BACKFILL AROUND THE ROOT BALL WITH PREPARED GROWING MEDIUM, TAMPING AND WATERING TO ENSURE FIRM SUPPORT FOR THE PLANT, AND ELIMINATING AIR POCKETS AROUND THE ROOT BALL.

5. FERTILIZER APPLICATION:

 PLACE PLANTING TABLETS AT THE FOLLOWING RATES IN THE PREPARED PLANTING HOLES. SPREAD THE TABLETS IN EACH HOLE BEFORE PLANTING.

PLANT SIZE/ CONTAINER SIZE	TABLET SIZE	TABLETS PER PLANT
TREES	21g	1/25 CALIPER
18 GAL TUB	21g	3
7 GAL POT	21g	3
5 GAL POT	21g	2
2 GAL POT	21g	1
1 GAL POT	21g	1
OTHER SIZES AS	PER MANUFACTURER'S	RECOMMENDATIONS

6. MULCHING: MULCH ALL SHRUB AND GROUNDCOVER AREAS TO A 2" DEPTH.

PLANTS AND PLANTING CONT. EXECUTION:

7. GUYING AND STAKING

- GUY AND STAKE ALL TREES IMMEDIATELY AFTER PLANTING. PLANT MATERIAL NOT GUYED OR STAKED IMMEDIATELY SHALL BE REPLACED IF DAMAGED.
- DRIVE THREE (3) STAKES PER TREE (EQUALLY SPACED AROUND THE TREE)
 VERTICALLY INTO THE GROUND TO A DEPTH OF 2'-6" TO 3'-0"mm, IN SUCH A
 MANNER SO AS NOT TO INJURE THE ROOT OR ROOT BALL.
- FASTEN TREE TO THE CROTCH AND MIDWAY BETWEEN THE CROTCH AND THE GROUND WITH GALVANIZED WIRE PROTECTED BY HOSE.
- TREES TO STAND PLUMB UPON COMPLETION OF THIS OPERATION.

R PRIMING

PRUNE EACH TREE AND SHRUB PLANTED TO PRESERVE THE NATURAL CHARACTER OF THE PLANT IN A MANNER APPROPRIATE TO ITS PARTICULAR REQUIREMENT IN THE LANDSCAPE DESIGN. PRUNING IN GENERAL SHALL BE HEAVIER ON COLLECTED THAN ON NURSERY—GROWN PLANTS. REMOVE ALL SOFT WOOD SUCKER GROWTH AND ALL BROKEN OR BADLY BRUISED BRANCHES WITH A CLEAN CUT.

9. CLEAN UP:

- REMOVE FROM THE SITE ALL CANS, SURPLUS MATERIAL AND OTHER DEBRIS RESULTING FROM PLANTING OPERATIONS.
- NEATLY DRESS AND FINISH ALL PLANTING BEDS AND FLUSH ALL WALKS AND PAVED AREAS CLEAN TO THE SATISFACTION OF THE CONSULTANT AND THE OWNER


LANDSCAPE MAINTENANCE GENERAL:

1. ALL LANDSCAPE MAINTENANCE AND IRRIGATION TO BE COMPLETED BY LOCAL JURISDICTION.



velocite

REDMOND, WA 98052

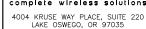



506 SECOND AVENUE, SUITE 1512 SEATTLE, WA 98104

PROJECT NO: 1802U022

DRAWNBY: W.T.

CHECKED BY: L.C.

CAD FILE:

SUBMITTALS

5	JUN 11/19	REVISED PER COMMENTS	WT
4	JUN 11/19	REVISED PER COMMENTS	WT
3	MAY 16/19	REVISED PER COMMENTS	WT
2	FEB 20/19	REVISED PER COMMENTS	

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ASE SEAL

SITE

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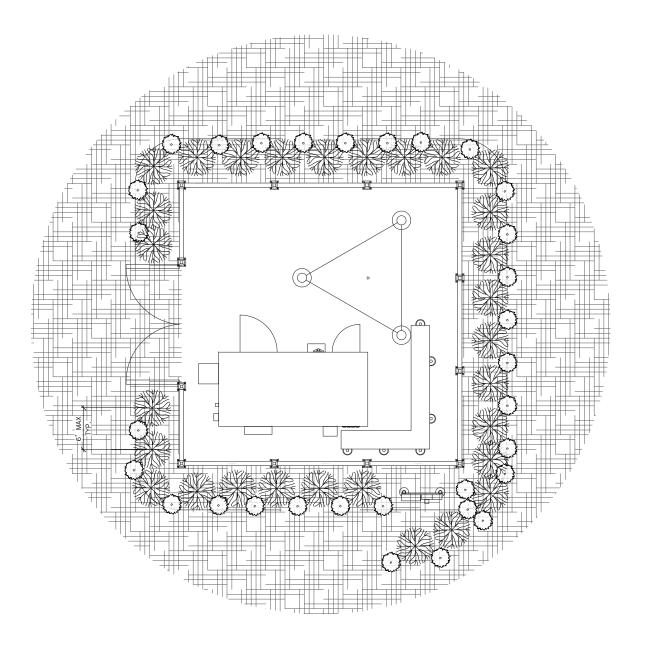
FA#: 14084511

SHEET TITLE

LANDSCAPE NOTES II

1 -2

EXHIBIT 10





NOTES:

- REFER TO L-1 AND L-2 FOR ALL LANDSCAPING SPECIFICATIONS.
- ALL LANDSCAPING AND PLANT MATERIAL SHALL BE IN ACCORDANCE WITH LOCAL JURISDICTION STANDARDS
- 3. ALL LANDSCAPING AND PLANTING TO BE APPROVED BY THE LOCAL JURISDICTION PRIOR TO PLANTING.

<u>LEGEND</u>				
SYMBOL	AMOUNT	BOTANICAL/COMMON NAME		
	29	EVERGREEN TREE		
0	31	POLYSTICHUM MUNITUM		
		MULCH		



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PROJECT NO: 1802U022

DRAWNBY: WT.

CHECKED BY: LC.

CAD FILE: L-3

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AGE S

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OTHELLO DT SP4359 640 E ELM ST OTHELLO, WA 99344

FA#: 14084511

SHEET TITLE

LANDSCAPE PLAN

SHEET NUMBER

EXHIBIT 10

NOTES:

- CREATE SOIL SAUCER

- REFER TO L-1 AND L-2 FOR ALL LANDSCAPING SPECIFICATIONS.
- 2. ALL LANDSCAPING AND PLANT MATERIAL SHALL BE IN ACCORDANCE WITH LOCAL JURISDICTION STANDARDS
- 3. ALL LANDSCAPING AND PLANTING TO BE APPROVED BY THE LOCAL JURISDICTION PRIOR TO PLANTING.



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PROJECT NO: 1802U022

DRAWN BY: W.T.

CHECKED BY:

CAD FILE:

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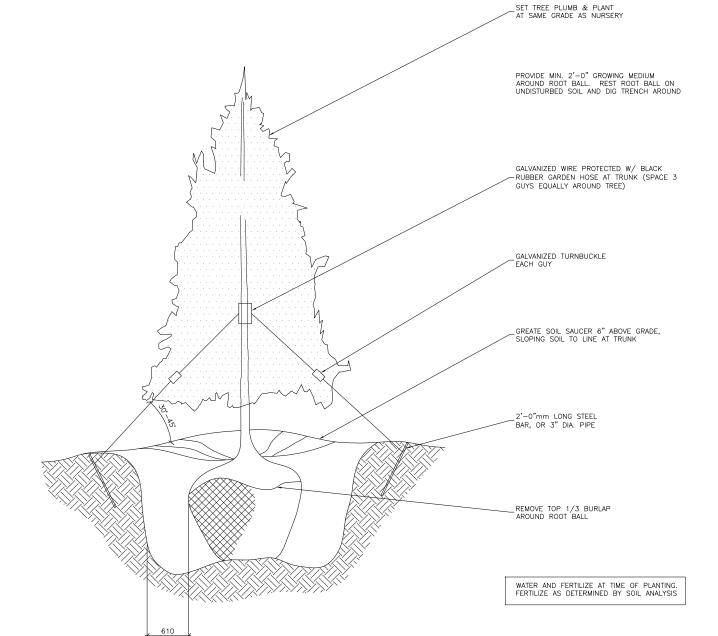
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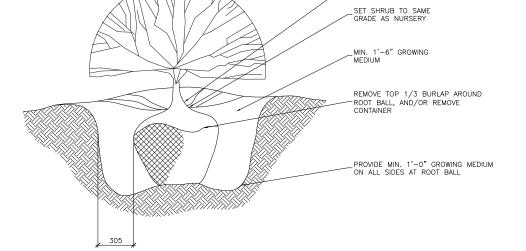
FA#: 14084511

SHEET TITLE

LANDSCAPE DETAILS



TYPICAL DECIDUOUS TREE PLANTING DETAIL



2 TYPICAL SHRUB PLANTING DETAIL
N.T.S.

OTHELLO DT

L-4



SURVEY DATE

BASIS OF BEARING
BEARNOS SHOWN HEREON ARE BASED UPON U.S. STATE PLANE
NAOSA COORDINATE SYSTEM WASHINGTON STATE PLANE COORDINATE
ZORE NORTH, DETERMINED BY GPS OBSERVATIONS.

BENCHMARK
PROJECT ELEVATIONS ESTABLISHED FROM CPS DERIVED ORTHOMETRIC HEIGHTS BY APPLICATION OF NOS 'QEOID 128' MODELED SEPARATIONS TO ELLIPSOID HEIGHTS DETERMINED BY REAL TIME KINETIC (RTK) QPS DATA PROCESSED ON THE WASHINGTON STATE REFERENCE NETWORK (WSRN). ALL ELEVATIONS SHOWN HEREON ARE REFERENCED TO THE

FLOOD ZONE

THIS PROJECT APPEARS TO BE LOCATED WITHIN FLOOD ZONE "X". ADDORDING TO FEDERAL EMEROPHCY MANAGEMENT AGENCY FLOOD INSURANCE RATE MAP(S), MAP ID #53001010250, DATED 01/16/2009

UTILITY NOTES
SURVEYOR DOES NOT QUARANTEE THAT ALL UTILITIES ARE SHOWN OR THER LOCATIONS ARE DEFINITE, IT IS THE RESPONSIBILITY OF THE CONTRACTOR AND EVELOPER TO CONTRACTOR AND EVELOPER TO CONTRACTOR AND EVELOPER TO LOCATE ALL UTILITIES PRIOR TO CONSTRUCTION. REMOVAL, RELOCATION AND/ OR REPLACEMENT IS THE RESPONSIBILITY OF THE CONTRACTOR.

SURVEYOR'S NOTES SURVEYOR HAS NOT PERFORMED A SEARCH OF PUBLIC RECORDS TO DETERMINE ANY DEFECT IN TITLE ISSUEC.

THE BOUNDARY SHOWN HEREON IS PLOTTED FROM RECORD INFORWATION AND DOES NOT CONSTITUTE A BOUNDARY SURVEY OF THE PROPERTY.

ALL DISTANCES SHOWN HEREON ARE ORID DISTANCES.

CRID-TO-GROUND SCALE FACTOR NOTE ALL BEARINGS AND DISTANCES ARE BASED ON THE WASHINGTON STATE SCUTH ZONE STATE PLANE ODORDINATE ZONE GRID. TO DERIVE GROUND DISTANCES DIVIDE BY 0.98987392

LESSOR'S LEGAL DESCRIPTION

372 FEET; THENCE SOUTH 00"03"25" WEST 333 FEET MORE ON LESS TO A POINT ON THE CENTERLINE OF CAK STREET LESS TO A POINT ON THE CENTEROTHE OF GRAN SHEET PRODUCED WESTERLY, THENCE EASTERLY ALONG SAID CENTERLINE 39D FEET NORS OR LESS TO A POINT ON SAID NORTH-BOUTH CENTERLINE OF SCOTION 3: THENCE NORTHERLY ALONG SAID CENTERLINE TO THE POINT OF BEGINNING.

REFERENCE IS MADE TO THE TITLE CUARANTEE #822418G1834, ISSUED BY CHICAGO TITLE INSURANCE OCHICARY, DATED SEPTEMBER 10, 2018 AT 8:00 AM. ALL EASEMENTS CONTAINED WITHIN SAID TITLE REPORT AFFECTING THE IMMEDIATE AREA SURROUNDING THE LEASE HAVE BEEN PLOTTED.

- EMIZED NOTES:
 THE PROPERTY HEREIN CESCRIBED IS CARRIED ON THE TAX
 ROLLS AS EXEMPT. HOWEVER, IT WILL BECOME TAXABLE ON
 THE DATE OF THE EMECLINON OF A CONVEYANCE TO A
 TAXABLE ENTITY AND SUBJECT TO THE LIEN OF REAL
 PROPERTY TAXES FOR THE BALANCE OF THE YEAR FROW
 THAT DATE TAX ASSOLINT NOW 182803680189 LEVY GODE: 11 (BLANKET IN NATURE)
- RESERVATIONS CONTAINED IN DEED CATED MARCH 10, 1964, RECORDED IN VOLUME 82 OF DEEDS, PAGES 145-146, RESERVED BY THE MILWAUKEE LAND COMPANY (BLANKET IN
- A MORTGAGE TO SECURE AN INDEBTEDNESS AS SHOWN BELOW DATED: MARCH 1, 1981 RECORDING DATE: MARCH 15, 1881 RECORDING NO.: 188299 VOLUME 8C PAGES 682-688 (BLANKET IN NATURE)

EXHIBIT 10

LEGEND

20

E Bites

112 100

TOWN.

—a—a—a—a—a—a—a—xxauakt iran fence

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- O Á+---- O Á+----- O Á+----- O VERHEÁD LINES

— — — — — — — — SETBACK LINES

STREET LIGHT

UTILITY METER

ELECTRICAL TRANSFORMER

UTILITY PEDESTAL

WATER CONTROL VALVE

CHAIN LINK FENCE

EXISTING BUILDINGS

SECTION LINES

STREET CENTERLINES RIGHT OF WAY LINES - SUBJECT PROPERTY LINE

FIRE HYDRANI

UTILITY POLE LIGHT POLE

UTILITY VAULT POSITION OF GEODETIC COORDINATES SPCT ELEVATION

GAB VALVE

CURBLINES CONCRETE LIMITS

- - ADJACENT PROPERTY LINE

---- EASEMENT LINES

LEASE AREA LEGAL DESCRIPTION
THAT PORTION OF THE SOUTHEAST QUARTER OF THE NORTHWEST QUARTER
OF SECTION 3, TOWNSHIP 15 NORTH, RANGE 29 EAST W.M., NORE
PARTICULARLY DESCRIBED AS FOLLOWS:

OCCUMENCING AT THE MONUMENTED INTERSECTION OF SOUTH 7TH AVENUE AND ELM STREET SOUTH;
THENCE ALONG THE CENTERLINE OF SAID SOUTH 7/14 AVENUE SOUTH
0.120'08" WEST, 209.04 FEED;
THENCE DEPARTING SAID CENTERLINE, NORTH 88'39'02" WEST, 243.75 FEET
TC THE POINT OF BEGINNING;

THENCE NORTH 00'00'00" EAST, 50.00 FEET; THENCE NORTH 90'00'00" EAST, 50.00 FEET RETURNING TO THE POINT OF

UTILITY EASEMENT NO. 1 LEGAL DESCRIPTION
THAT PORTION OF THE SOLTHEAST QUARTER OF THE MORTHWEST QUARTER
OF SECTION 5, TOWNSHIP IS NORTH, RANGE 29 EAST W.M., BEING A 10.00 FOOT WIDE STRIP OF LAND, LYNING S.00 FEET EACH SIDE OF FOLLOWING

OCHMENOING AT THE MONUMENTED INTERSECTION OF SOUTH 7TH AVENUE AND ELM STREET SOUTH;

THENCE DEPARTING SAID CENTERLINE, SOUTH 00'80'11" EAST, 187.32 FEET

THENCE ALCHO THE CENTERLINE OF SAID ELM STREET, SOUTH 89°C9'48" WEST, 261.59 FEET;

THENCE SOUTH 88'51'58" EAST, 26.86 FEET; THENCE SOUTH 01"2'02" WEST, 148.15 FEET; THENCE NORTH 85'63'44" WEST, 8.96 TO THE POINT OF TERMINUS.

POSITION OF GEOGRIC COORDINATES LATITUDE 48' 48' 13.24" (48.822344") NORTH (NAD83) LONGITUDE 119' 09' 38.62" (119.18256")WEST(NAD83) GROUND ELEVATION & 'OSLO' (NAV388)

GRAPHIC SCALE

1 inch = 25 ft.

CONTAINING 1800.5 SQ. FT. (0,041 AC.), MORE OR LESS.

THENCE SOUTH 00'00'00" EAST, 50.00 FEET; THENCE NORTH 90'00'00" WEST, 50.00 FEET;

TO THE POINT OF BEGINNING

OCHTAINS 2,500 SQ. FT. (0.087 AC.), WORE OR LESS.

- - - I FASE AREA LIMITS ___ _ _ _ _ _ _ MAJOR CONTOUR INTERVAL

GUY WRE AS NOTED OSES UTILITY MANHOLES

ASPHALT

BLDG CLF CMU

CONC D/W EP FC LP

NO R/W SL SW WALL

TOP OF BUILDING CHAIN LINK FENCE CONCRETE MASONRY UNIT

EDGE OF CONCRETE

ACCESS DRIVEWAY EDGE OF PAVEMENT FACE OF CURB LIGHT POLE

WROUGHT IRON FENCE

NATURAL GRADE

RIGHT OF WAY STREET LIGHT SIDEWALK TOP OF WALL

TREES

UTILITY EASEMENT NO. 2 LEGAL DESCRIPTION
THAT PORTION OF THE SOUTHEAST QUARTER OF THE NORTHWEST QUARTER
OF SECTION 3, TOWNSHIP 15 NORTH, RANCE 29 EAST W.M., BEING A 5.00
FOOT WIDE STRIP OF LAND, LYNIO 2.50 FEET EACH SIDE OF FOLLOWING DESCRIBED CENTERLINE:

COMMENCING AT THE MONUMENTED INTERSECTION OF SOUTH 7TH AVENUE AND ELM STREET SOUTH: THENCE ALONG THE CENTERLINE OF SAID SOUTH 7TH AVENUE SOUTH

01"20'08" WEST, 259,04 FEET; THENCE DEPARTING SAID CENTERLINE, NORTH 88'39'82" WEST, 243.75 FEET; THENCE NORTH 80'00'00" WEST, 19.80 FEET TO THE POINT OF BEGINNING;

THENCE NORTH 00°00'00" EAST, 69.91 FEET TO THE POINT OF TERMINUS.

CONTAINS 350 SQ. FT. (C.OOS AC.), MORE OR LESS.

ACCESS NOTE

RESERVING NOMEXCLUSIVE RIGHT OF USE ACROSS LESSOR'S PROPERTY FOR NECESSARY APPURITHANCES TO CONSTRUCT, OPERATE, AND MAINTAIN A COMMUNICATION FACILITY FOR ITEMS SUCH AS, BUT NOT LIMITED TO IMORESS, EGRESS, PARKING, VEHICULAR MANEUVERING, EQUIPMENT, AND UTILL TIES.

UTILITY EASEMENT NO. 3 LEGAL DESCRIPTION THAT PORTION OF THE SOUTHEAST QUARTER OF THE NORTHWEST QUARTER
OF SECTION 3. TOWNSHIP 15 NORTH, RANGE 28 EAST W.M., BEING A 5.00
FOOT WICE STRIP OF LAND, LYING 2.50 FEET EACH SIDE OF FOLLOWING DESCRIBED CENTERLINE:

COMMENCING AT THE MONUMENTED INTERSECTION OF SOUTH 7TH AVENUE AND ELW STREET SOUTH; THENCE ALONG THE CENTERLINE OF SAID SOUTH 7TH AVENUE SOUTH 01'20'02" WEST, 259.04 FEET:


THENCE CEPARTING SAIC CENTERLINE, MORTH 88'39'32" WEST, 243.75 FEET; THENCE SOUTH CO'OC'OO" EAST, 50.00 FEET; THENCE NORTH 90'00'00" WEST, 4.50 FEET TO THE POINT OF BEGINNING:

THENČE SOUTH 51°05°16" WEST, 28.43 FEET; THENČE SOUTH 88°35'44" EAST, 7.49 FEET TO A POINT HEREON REFERRED TO AS POINT "A"; THENCE CONTINUING SOUTH 85'53'44" EAST, 8.46 FEET TO A POINT OF

TOGETHER WITH BEGINNING AT SAID POINT "A"; THENCE SOUTH CITCS"16" WEST, 11.67 FEET TO A POINT OF TERMINUS

NORTHERLY SIDELINES OF EASEMENT TO BE LENGTHENED OR SHORTENED TO ABUT SOUTH LINE OF A NOW OR FUTURE LEASE AREA.

CONTAINS 244 SQ. FT. (0.005 AC.), MORE OR LESS.

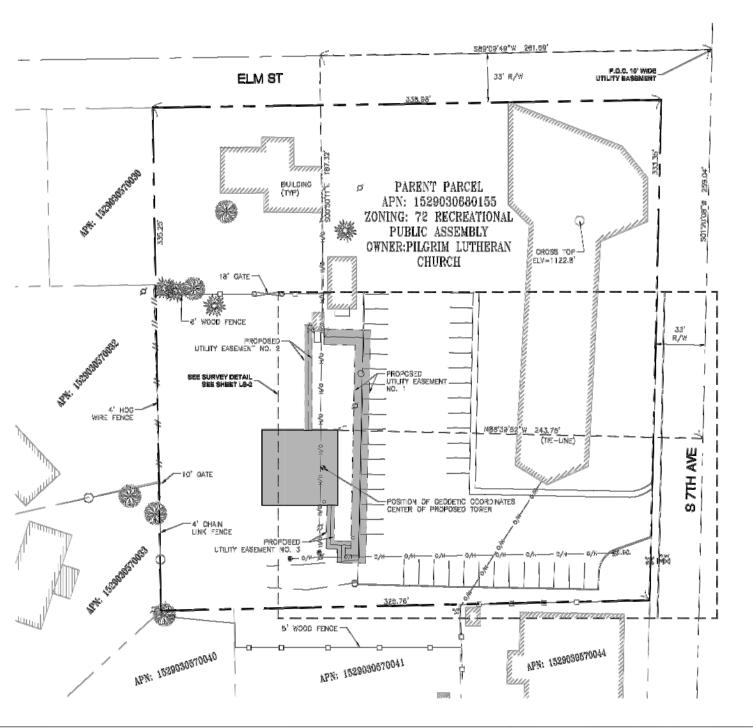



PROJECT INFORMATION:=

SP4359 OTHELLO DT 640 E ELM ST OTHELLO WA 99344 ADAMS COUNTY

ORIGINAL SSUE DATE:

10/15/2018

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		Α	10/16/18	PRELIM	Jly
		В	11/01/18	ADD ESMT	DO
		С	01/11/19	DESIGN	RA
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PLANS PREPARED BY:



CONSULTANT:



DRAWN BY: =APV.s

245 SAINT HILLIES AVE.

TACOMA, WASHINGTON 98402

PH, (253) 373-9181

SUITE BA

SR MF LICENSER:



SHEET TITLE:

SITE SURVEY

SHEET NUMBER:

